

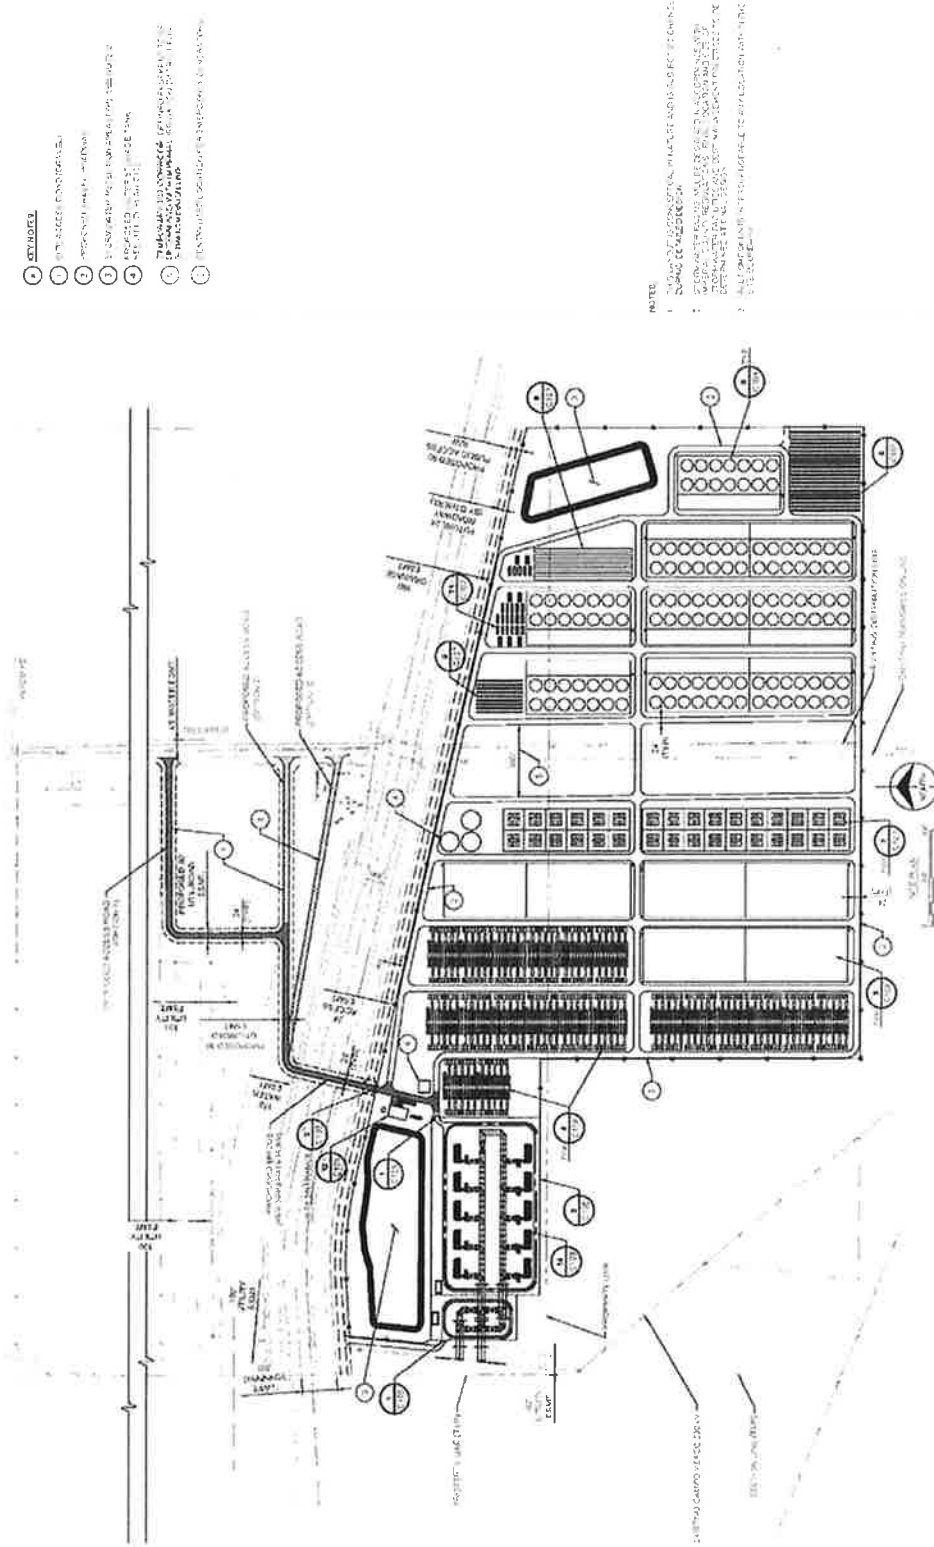


B. Site Map

Figure 3. Proposed Site Plan

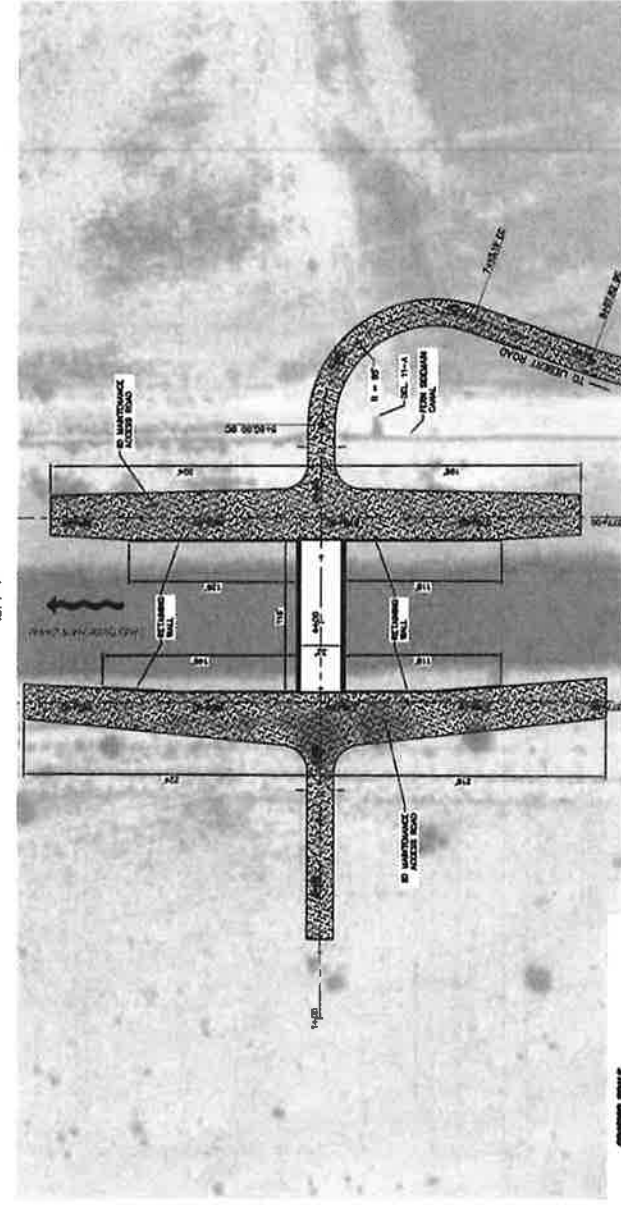


11/15

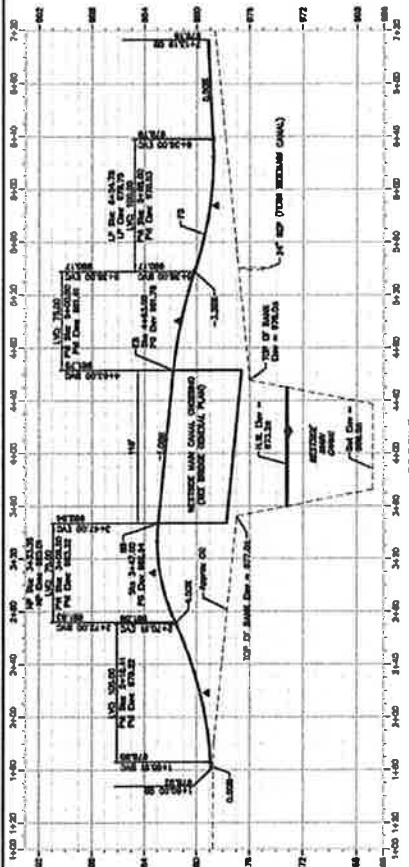


PROFILE SCALE 1" = 40'
PLAN SCALE 1" = 40'

REVISION	DATE	COMMENTS


PREPARED UNDER THE DIRECT SUPERVISION OF: TITLE: P. E. _____ N.Y.C. _____		COUNTY OF IMPERIAL PUBLIC WORKS DEPARTMENT APPROVED FOR CONSTRUCTION BY: ROAD COMMISSIONER DATE _____ TIME: 10:00 AM	
COUNTY OF IMPERIAL EL CENTRO, CALIFORNIA		PUBLIC WORKS DEPARTMENT COUNTY OF IMPERIAL EL CENTRO, CALIFORNIA	
WESTSIDE CANAL BATTERY STORAGE COMPLEX PROJECT WESTSIDE MAIN CANAL CROSSING		PLAN AND PROFILE SHEET NO. PP-1 OF _____	

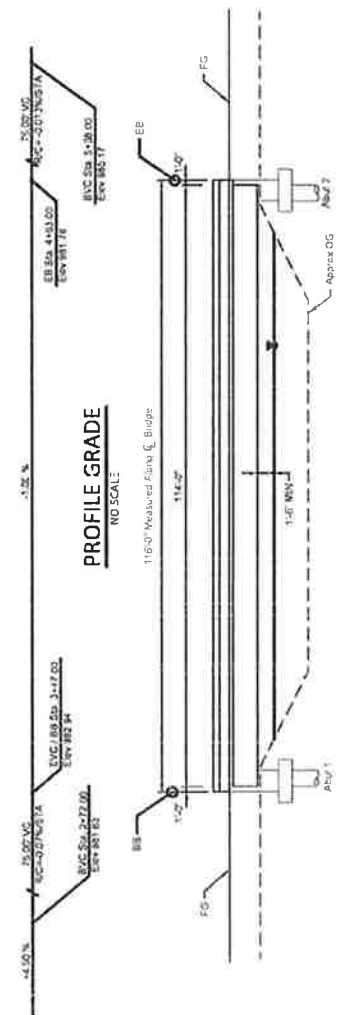

PROFILE GRADE
NO SCALE

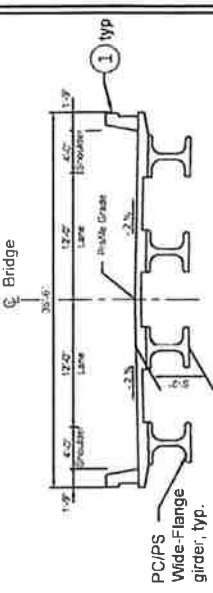

TYPICAL SECTION
SCALE 1" = 5'-0"

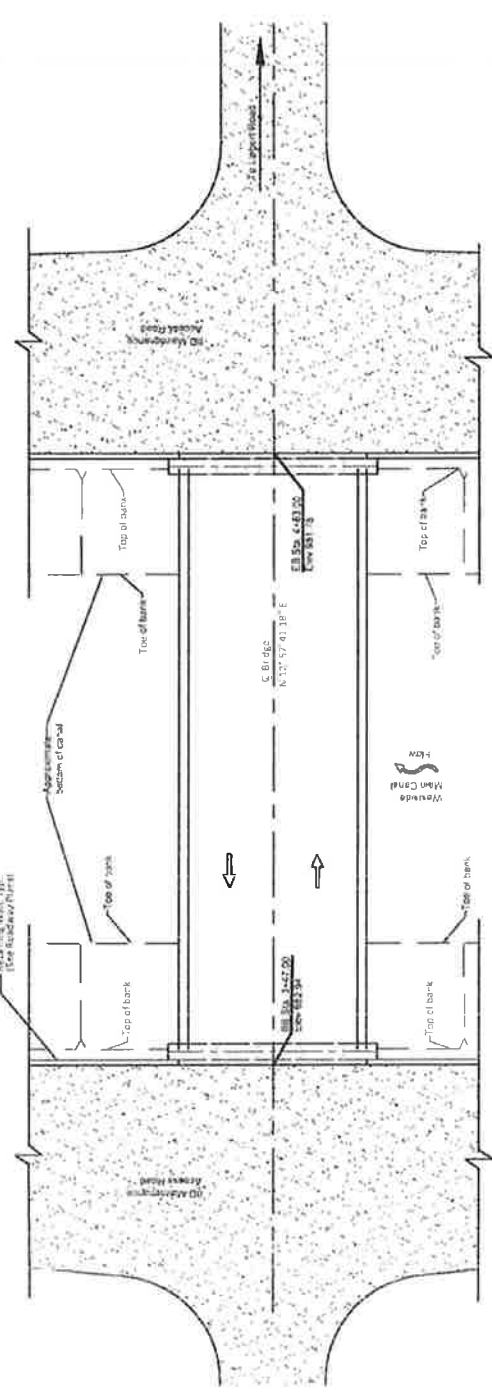

ELEVATION
SCALE 1" = 10'

LEGEND
 ↳ Indicates Direction Of Traffic
 ↳ Indicates Direction Of Flow

NOTES
 Concrete Barrier Type 886
 High Water Elevation = 523.20'

DATE OF ESTIMATE: MAY 2018
 STRUCTURE DEPTH: 5'-2"
 LENGTH: 116'-0"
 W.C. #1: 35'-0"
 W.C. #2: 35'-0"

COST 750 FT INCLUDING
 25% CONTINGENCY = \$180,000.00
 TOTAL COST = \$1,250,000.00

PLAN
SCALE 1" = 20'

REVISION	DATE	COMMENTS		
	DATE		WESTSIDE CANAL BATTERY STORAGE COMPLEX PROJECT WESTSIDE MAIN CANAL CROSSING	
PREPARED UNDER THE DIRECT SUPERVISION OF: DATE: _____			COUNTY OF IMPERIAL PUBLIC WORKS DEPARTMENT APPROVED FOR CONSTRUCTION BY: DATE: _____	
GENERAL PLAN SHEET NO. S-1 OF 10 SHEETS			EL CENTRO, CALIFORNIA	